### **PROJECT LOCATION**

### **CITY OF THOMPSON FALLS CHURCH STREET WATER MAIN** REPLACEMENT

**CONSTRUCTION PLANS** 

SECTION 04, 05, 08, 09, TOWNSHIP 21N, AND RANGE 29W

### PLANS PREPARED FOR:

RUSSLYN LEIVESTAD, MAYOR CITY OF THOMPSON FALLS



### APPROVED BY:

CARRIE GARDNER, P.E. GREAT WEST ENGINEERING



### QA/QC BY:

LEVI HOWELL, P.E.



### PLANS PREPARED BY:

PAUL KARCHER, EI





NOT TO SCALE

### SHEET INDEX

COVER

PROJECT: 1-21204-TO4 DATE: AUGUST 28, 2024

GENERAL SHEET 1

SHEET 2 GENERAL NOTES OVERALL SITE PLAN

WATER MAIN REPLACEMENT SHEET 4


PLAN AND PROFILE - STA. 0+00 TO STA. 7+00 - STA. 0+00 TO STA. 7+00 PLAN AND PROFILE - STA. 7+00 TO STA. 13+00 - STA 7+00 TO 13+00


DETAILS

SHEET 6 SHEET 7 DETAILS

### RURAL DEVELOPMENT - CRDA #10.760 ARPA - AMC-23-0068

NO.	REVISION DESCRIPTION	BY	DATE	SET NO.
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$\overline{\triangle}$				SHEET NO.
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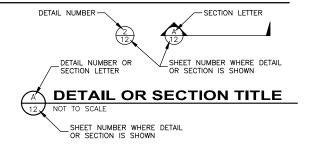


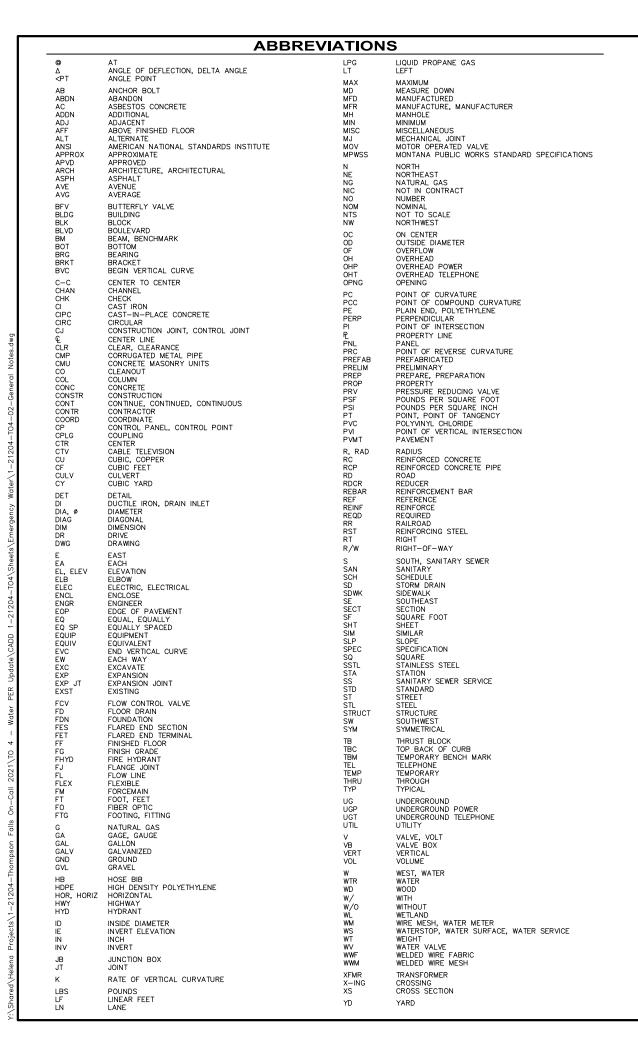
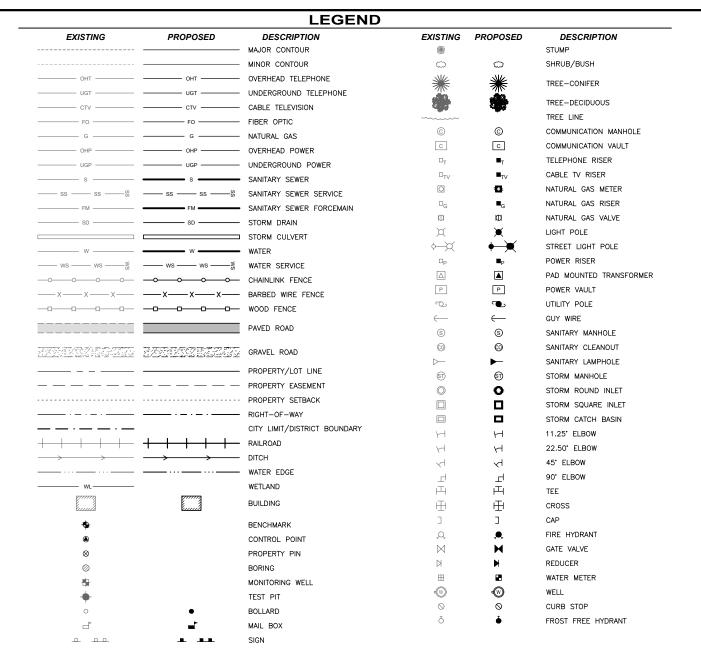
### **GENERAL NOTES:**

- THIS IS A STANDARD LEGEND AND ABBREVIATION LIST. THEREFORE, NOT ALL SYMBOLS AND ABBREVIATIONS MAY BE USED ON THIS PROJECT.
- UNLESS MODIFIED BY THE CONTRACT DOCUMENTS, ALL WORK WILL CONFORM TO THE MONTANA PUBLIC WORKS STANDARD SPECIFICATIONS, SEVENTH EDITION, APRIL 2021 (REFERRED TO COLLECTIVELY AS MPWSS).
- 3. EXISTING UNDERGROUND UTILITIES SHOWN ARE FROM THE BEST INFORMATION AVAILABLE. THIS INFORMATION IS APPROXIMATE AND MAY BE INCOMPLETE. FOR ACCURATE LOCATION, THE CONTRACTOR SHALL CONTACT, PRIOR TO EXCAVATION, THE UTILITIES UNDERGROUND LOCATION CENTER AT: 1-800-424-5555.

### **GENERAL DESIGN DESIGNATIONS:**



# PROJECT: 1-21204-TO4 NO. REVISION DESCRIPTION BY DATE OF SIGNED: BA DATE OF SIGNED: BA DATE OF SIGNED: DATE OF

Great West ENGINERING 250 BELY VEW DRIVE HELDIN MR (408449627


CHURCH STREET WATER MAIN
REPLACEMENT

GENERAL

SHEET NO.

2

OF 7

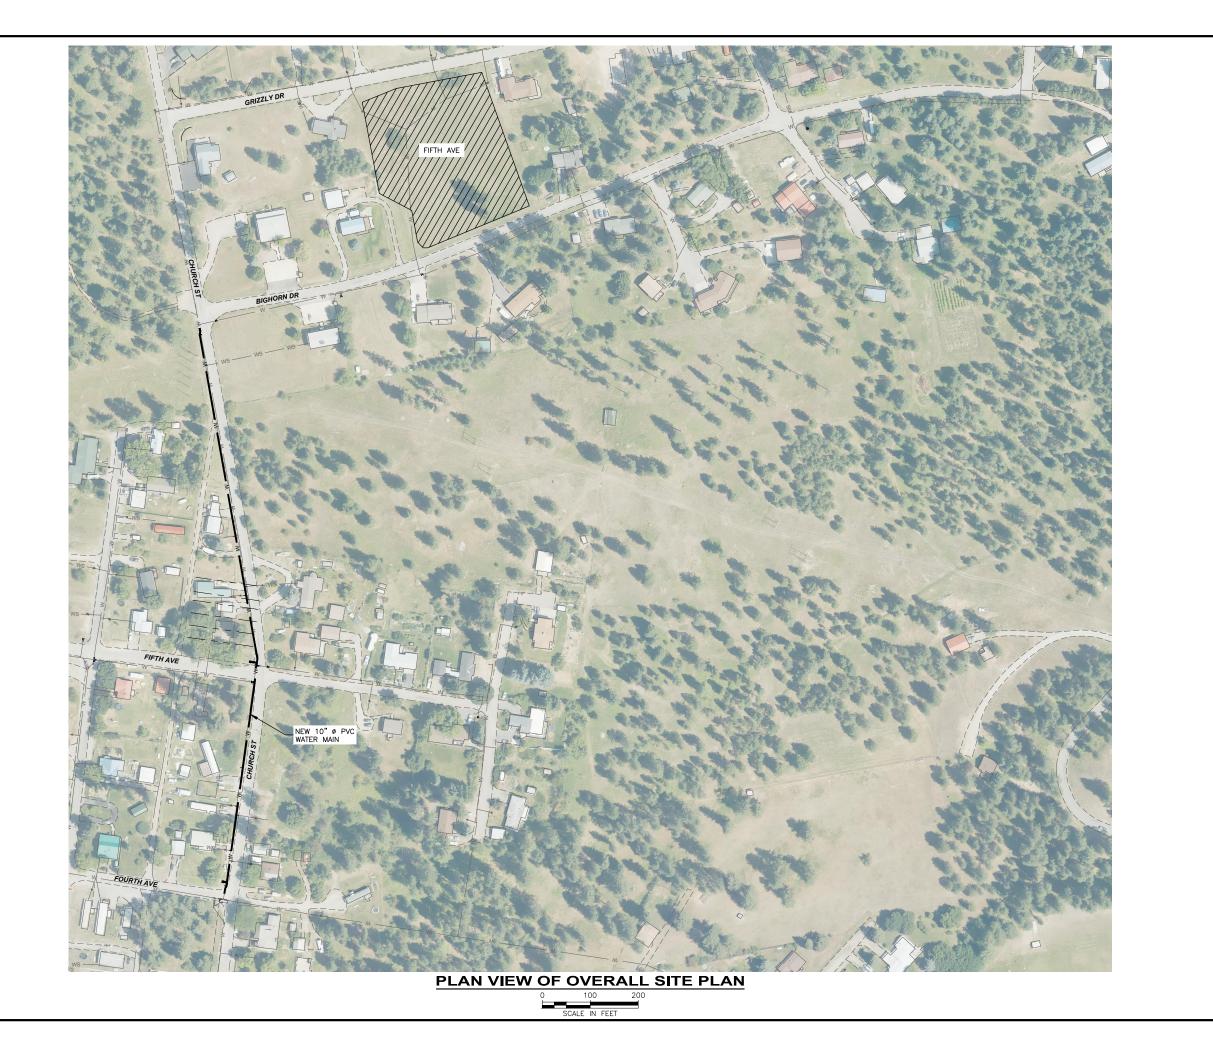

Great West in E R IN 6

2501 BELT VIR WONTE WAT 14 CHECKED: DAM

2501 BELT VIR WONTE WONTE WAT 15 CHECKED: DAM


2601 BELT VIR WONTE WAT 15 CHECKED: DAM

2601 BE


## CHURCH STREET WATER MAIN REPLACEMENT

OVERALL SITE PLAN

SHEET NO.

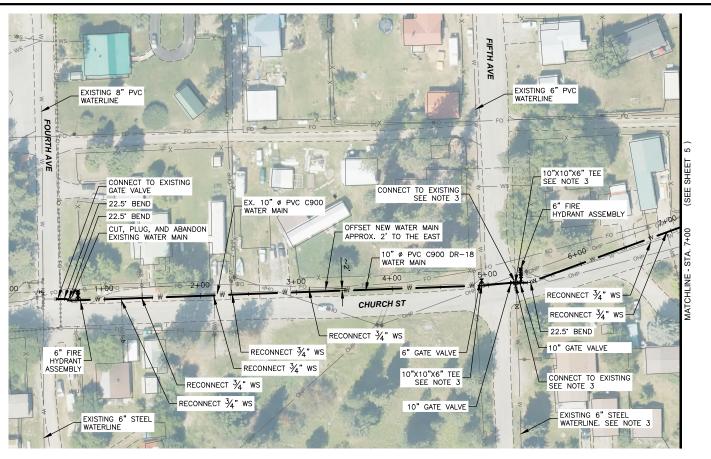



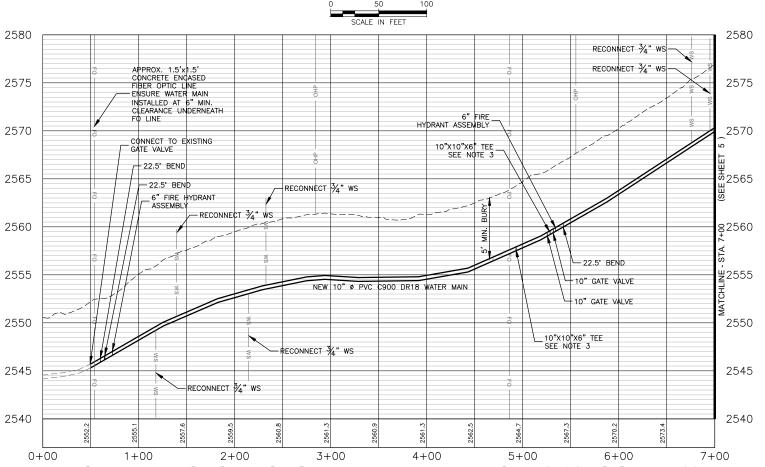

### PROFILE VIEW OF CHURCH STREET WATER MAIN - STA. 0+00 TO STA. 7+00

HORIZONTAL SCALE: 1" = 100' VERTICAL SCALE: 1" = 10'



PROJECT: 1-21204-T04	o N	REVISION DESCRIPTION	В	Δ
DESIGNED: BA	$\triangleleft$			
BRAWN: RLH	$\triangleleft$			
CHECKED: DMM	$\triangleleft$			
APPROVED: SEB	$\triangleleft$			
DATE: AUGUST 28, 2024	$\leq$			





### OF THOMPSON FALLS 4 STREET WATER MAIN REPLACEMENT STA.

STA. 0+00 TO

PROFILE

PLAN AND


### NOTES:

- EXISTING UNDERGROUND INSTALLATIONS & PRIVATE UTILITIES SHOWN ARE INDICATED ACCORDING TO THE BEST INFORMATION AVAILABLE TO THE ENGINEER THE ENGINEER DOES NOT GUARANTEE THE ACCURACY OF SUCH INFORMATION. SERVICE LINES (Water, Power, Gas, Television, Telephone) MAY NOT BE STRAIGHT LINES OR AS INDICATED ON THE PLANS. STATE LAW REQUIRES CONTRACTOR TO CALL ALL UTILITY COMPANIES BEFORE EXCAVATION FOR EXACT LOCATIONS.
- ALL WORK TO BE IN ACCORDANCE WITH MONTANA PUBLIC WORKS STANDARD SPECIFICATION 7TH EDITION.
- 3. CONTRACTOR TO VERIFY SIZE OF EXISTING WATERLINE, WATER SERVICES, FITTINGS AND APPURTENANCES WHEN INSTALLING NEW AND CONNECTING TO EXISTING.


SHEET NO.

CHURCH 8



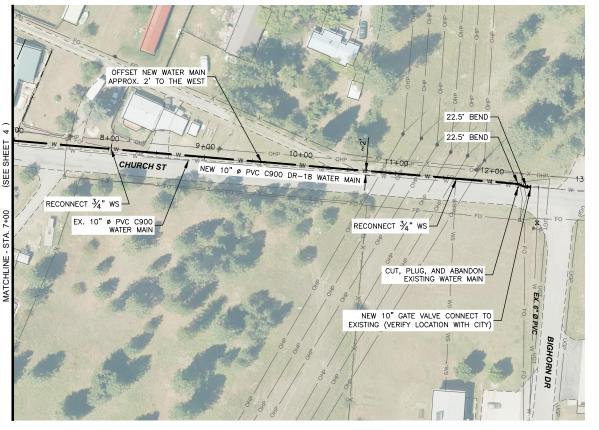

### PLAN VIEW OF CHURCH STREET WATER MAIN - STA 7+00 TO 13+00

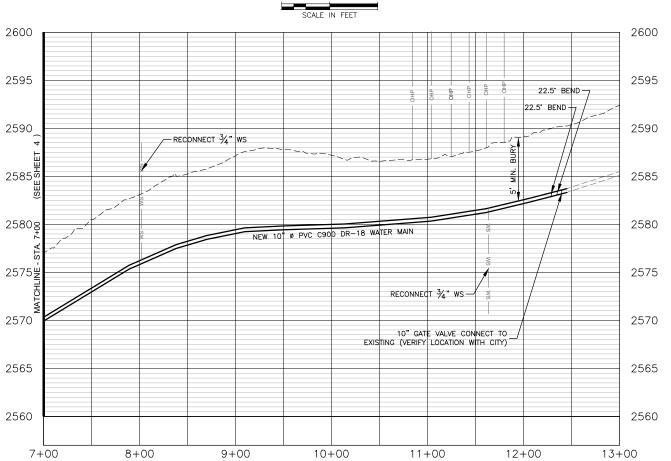

PROFILE VIEW OF CHURCH WATER MAIN - STA. 7+00 TO STA. 13+00

HORIZONTAL SCALE: 1" = 100' VERTICAL SCALE: 1" = 10'

### NOTES:


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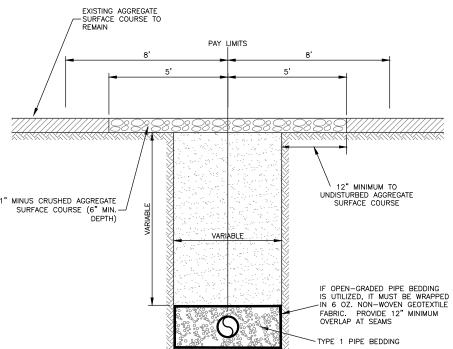



13+00 7+00 TO STA.

CHURCH STREET WATER MAIN
REPLACEMENT - STA. PLAN AND PROFILE

SHEET NO.




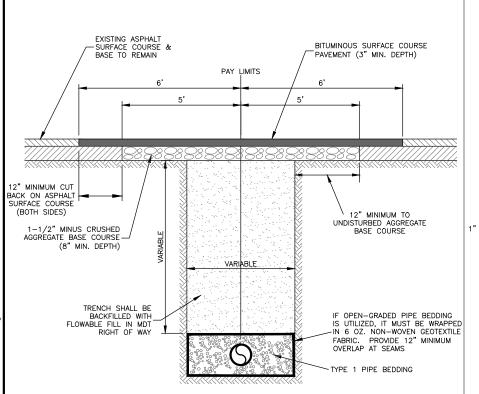

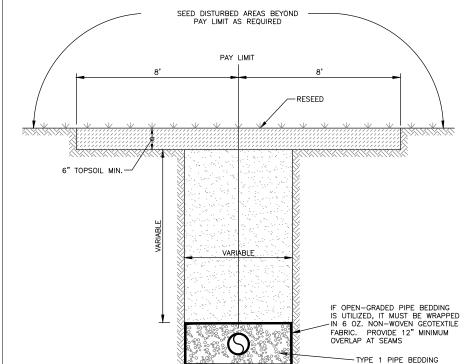

### TYPE "C" SURFACE RESTORATION


### **TYPE "A" SURFACE RESTORATION**

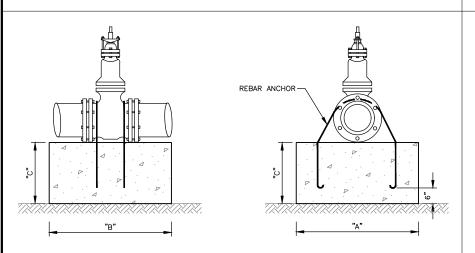

0	NDAR CK D			
ANCHOR ROD	VALVE	1	50 PSI	
SIZE	SIZE	"A"	"B"	"C"
3/4"	6 <b>"</b>	2'-0"	2'-0"	2'-0"
3/4"	8"	2'-0"	2'-0"	2'-0"
3/4"	10"	2'-6"	2'-6"	2'-0"
3/4"	12"	3'-0"	3'-0"	2'-8"

- NOTES: 1. COAT RODS WITH "KOPPERS" BITUMASTIC NO. 50 COATING OR EQUIVALENT.
  - 2. PRESSURES SHOWN IN TABLE ARE MAXIMUM OPERATING PRESSURES IN SYSTEM.
  - 3. CONCRETE COMPRESSIVE STRENGTH TO BE 3,000 PSI



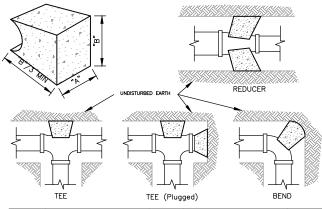


**TYPE "B" SURFACE RESTORATION** 

		STANDARD	DIMENSI	ONS FOR	THRUST	BLOCKING		
FITTING	TEES &	PLUGS	90 °	BEND	45 BEND	& WYES	REDUC 22 1/:	ERS & 2° BEND
SIZES	Α	В	Α	В	Α	В	Α	В
4"	1'-7"	1'-2"	1'-9"	1'-6"	1'-8"	0'-10	' 1'–7"	0'-6"
6"	2'-0"	1'-11"	2'-5"	2'-2"	1'-10"	1'-7"	1'-9"	0'-10"
8"	2'-8"	2'-6"	3'-2"	3'-0"	2'-5"	2'-1"	1'-9"	1'-6"
10"	3'-4"	3'-3"	4'-0"	3'-10"	3'-0"	2'-9"	2'-2"	1'-11"
12"	4'-0"	3'-10"	4'-8"	4'-8"	3'-8"	3'-3"	2'-7"	2'-3"

- NOTES:
  1. TABLES BASED UPON 150 PSI MAIN PRESSURE AND 2,000 PSF SOIL BEARING PRESSURE.
  2. WRAP ALL FITTINGS WITH POLYETHYLENE.
- CONCRETE COMPRESSIVE STRENGTH TO BE 3,000 PSI



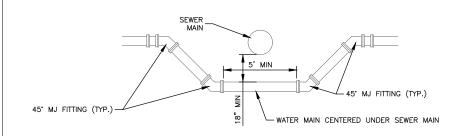

- WATER MAIN ADJUSTMENT NOTES


  1. ALL FITTINGS SHALL BE MECHANICAL JOINT RESTRAINT TYPE, MEGA LUG, OR APPROVED EQUAL.
- 2. THRUST BLOCKS SHALL BE INSTALLED PER MPW STANDARD DRAWING 02660-1.
- WATER MAIN AND FITTINGS SHALL BE CLEANED AND DISINFICTED ACCORDING TO MPW SECTION 02660 WATER DISTRIBUTION.

**SEWER-WATER VERTICAL SEPARATION** NOT TO SCALE

GreatWes 2501 BELT VIEW DRIVE HELENA, MT 59601 (406)449-8627

> OF THOMPSON FALLS
>
> 4 STREET WATER MAIN
>
> REPLACEMENT CHURCH & CITY

> > SHEET NO. 6

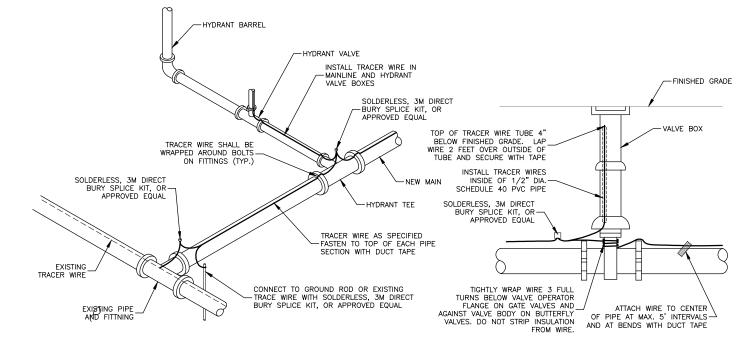

- GENERAL NOTE:

  1) TRACER WIRE SHALL TERMINATE INSIDE VALVE BOX
  WITH ENOUGH SLACK TO REACH 2' ABOVE GROUND
  SURFACE.
- SURFACE.

  2) ALL WIRE AND CABLE SHALL BE JACKETED #14
  COPPER WIRE. THE BORES AND DIRECTIONAL DRILLS
  SHALL USE JACKETED #12 COPPER WIRE.

  3) ALL SPLICED OR REPAIRED WIRE CONNECTIONS IN
  THE TRACER WIRE SYSTEM SHALL BE MADE USING
  SOLDERLESS, 3M DIRECT BURY SPLICE KIT, OR
  APPROVED EQUAL.

  4) NO SPLICES ALLOWED FOR WIRE LENGTHS LESS
  THAN 500 FEET.



	PROJECT: 1-21204-T04	ON	REVISION DESCRIPTION	ВУ	DATE
OOO C	DESIGNED: PTK	$\triangleleft$			
arx	BRAWN: PTK, AB	$\triangleleft$			
DOS.	CHECKED: JSP	$\triangleleft$			
9	APPROVED: CAG	$\triangleleft$			
	DATE: AUGUST 28, 2024				



### Great West ENGINEERING SEG BELYNGE HELEN, MT 59001 (400)449-8627

## CHURCH STREET WATER MAIN REPLACEMENT

DETAILS

SHEET NO.